


CONDENSER MOUNT

Monkeytoe Stacked Condenser Mount

PRODUCT DESCRIPTION

Adjustable aluminium stacked mounting system for HVAC units/packs.

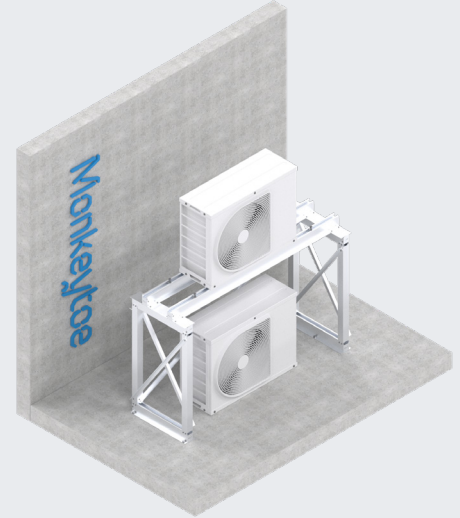

TYPICAL USES / APPLICATIONS

- Mounting of A/C units on top of each other to save space.
- Raised mounting of pipework, cable trays, A/C and refrigeration Plant.
- Can be used as a base for raised walkway access systems.
- Roof top mounting for air conditioning condenser units

CHARACTERISTICS / ADVANTAGES

- Modular, easy and fast installation.
- Heavy duty – Units up to 150kg
- Robust – High Tensile, marine grade Aluminum.
- Suitable for a wide variety of raised mounting applications.
- Can be fixed to different ground surfaces in a variety of ways.

TECHNICAL DATA / MATERIALS

- High Tensile, marine grade Aluminum.
- Fixings: Stainless Steel 304 Grade

TESTS

APPROVALS / STANDARDS


- Structural design action B1 & B2
- AS/NZS 1170 Standards Australia / New Zealand (Relevant parts)
- Transmission loss testing conducted by University of Auckland Acoustic Testing Services, to both ISO
- ISO 10140-2 (Reports available by request)

WARRANTY

- 25 years materials
- Product Warranty is valid in accordance to the PS1 Engineering Standard that it has been designed to

MAINTENANCE

- It is recommended that plant platforms are included in the standard 'building warrant of fitness' inspections.
- All damage or loose fixings to be reported immediately to asset manager or building owner for correction.

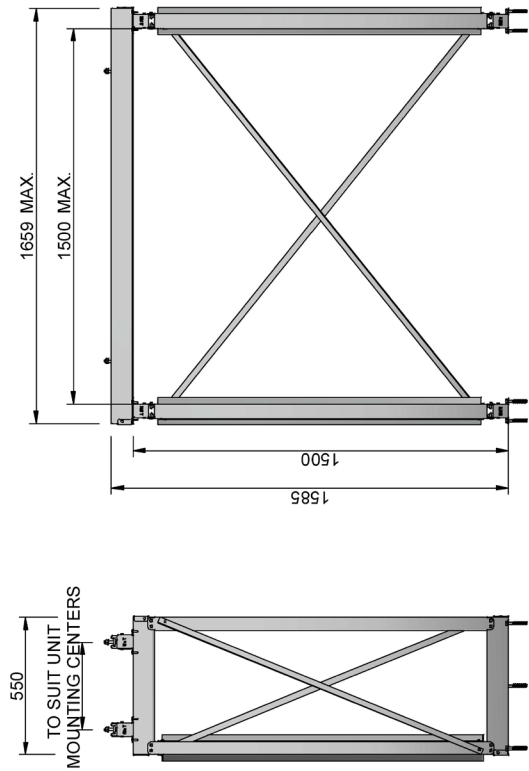

FRONT ELEVATION
1:20




SIDE ELEVATION
1:20

ITEM	CODE	DESCRIPTION	ITEM QTY.	PACK QTY.	CUT LENGTH	PKD	CHKD
1	CS026.15	58.5 x 53 x 2.5mm RHS	4	4			
2	FNS10.1	M10 Stainless Steel Nyloc Nut	4	4			
3	FNS10.4	M10 Stainless Steel Spring Nut With Stud	4	4			
4	FTS01.22	12g x 22mm Stainless Steel Self Drilling Tek	72	72			
5	FWS10.1	M10 Stainless Steel Washer	4	4			
6	PA025.025 03	25 x 3 Equal Angle	2	2	2050 mm		
7	PA025.025 03	25 x 3 Equal Angle	4	4	1394 mm		
8	PEC35	PM36 End Cap	12	12			
9	PM36	85 x 53mm Extrusion	2	2	1659 mm		
10	PM36	85 x 53mm Extrusion	4	4	550 mm		
11	PURCHASE	M8 FASTENER - TO SUIT GROUND	6	6			

DESIGN LOADS

DEAD LOAD

Max superimposed = 150kg

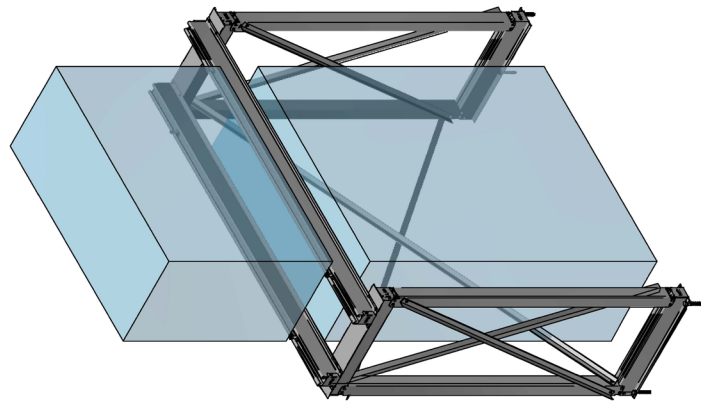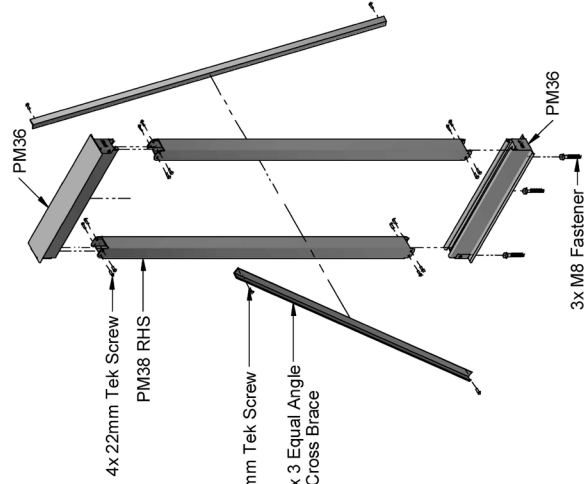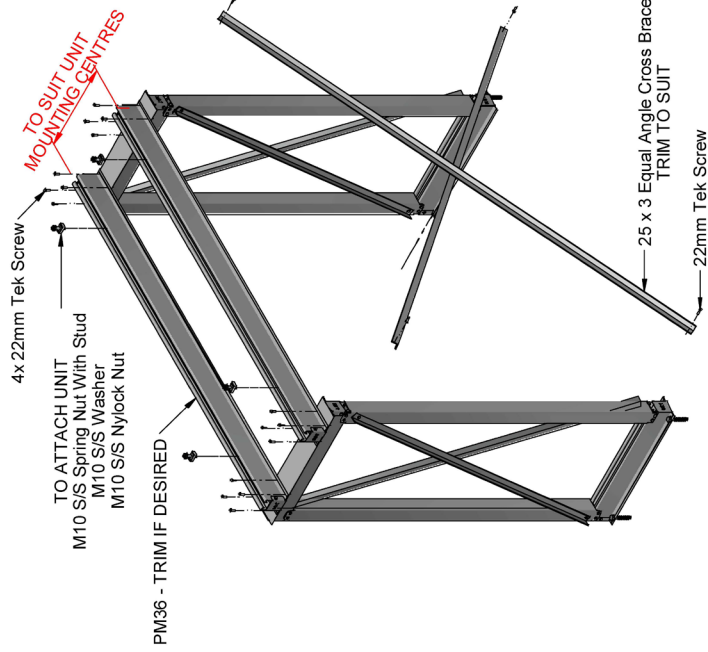


ISO VIEW
1:20

DRAWN BY:	KM
MODELED BY:	KM
PM:	BH
CHECKED BY:	BP/BD/LK
DATE DRAWN:	10/07/2019
LAST SAVED:	10/07/2019
MATERIAL:	SEE B.O.M.
FINISH:	MILL


Monkeytoe

EVERYTHING BETTER
0800 658 637 - www.monkeytoe.co.nz

CS025.15 1500mm Stacked Condenser Mount			
MONKEYTOE GROUP			
DWG No:	2004-CS025-15	2004	
	SHEET 1 OF 1		A3
	SCALE: 1:18		REV/01
DO NOT SCALE		DIMENSIONS IN MILLIMETERS	


ITEM	CODE	DESCRIPTION	ITEM QTY.	PACK QTY.	CUT LENGTH	POK'D	CHK'D
1	CS026.10	58.5 x 53 x 2.5mm RHS	4	4			
2	FNS10.1	M10 Stainless Steel Nyloc Nut	4	4			
3	FNS10.4	M10 Stainless Steel Spring Nut With Stud	4	4			
4	FTS01.22	12g x 22mm Stainless Steel Self Drilling Tek	72	72			
5	FWS10.1	M10 Stainless Steel Washer	4	4			
6	PA025.025.03	25 x 3 Equal Angle	2	2	1784 mm		
7	PA025.025.03	25 x 3 Equal Angle	4	4	948 mm		
8	PEC35	PM36 End Cap	12	12			
9	PM36	85 x 53mm Extrusion	2	2	1659 mm		
10	PM36	85 x 53mm Extrusion	4	4	550 mm		
11	PURCHASE	M8 FASTENER - TO SUIT GROUND	6	6			

DESIGN LOADS
DEAD LOAD
Max superimposed = 150kg

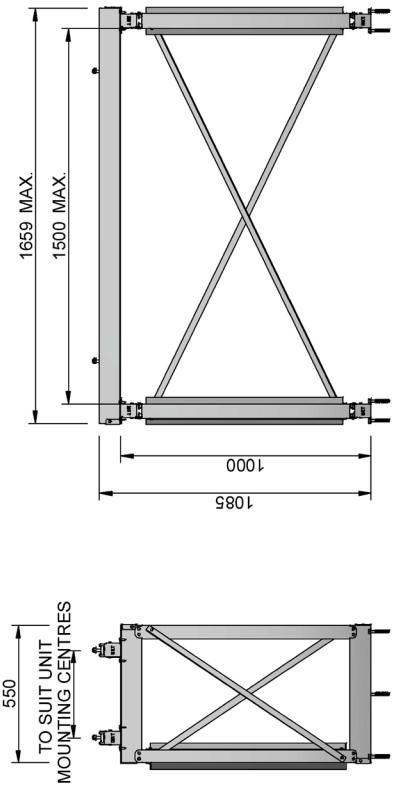


FRONT ELEVATION
1:20

SIDE ELEVATION
1:20

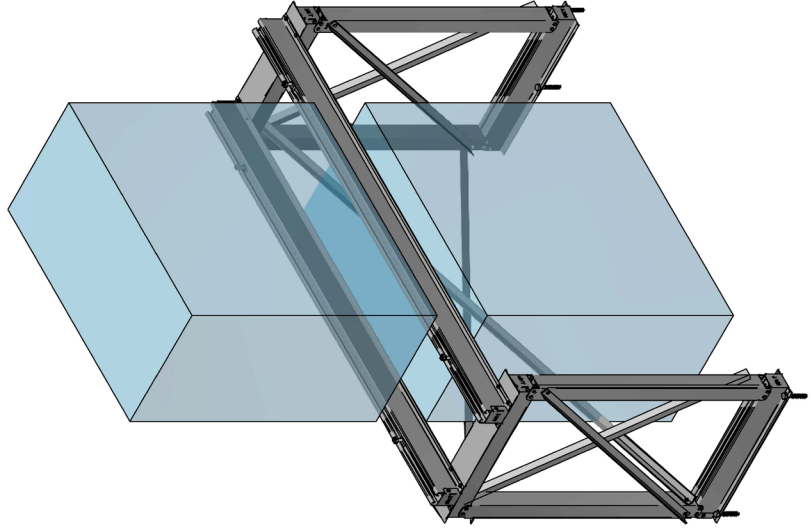

ISO VIEW
1:15

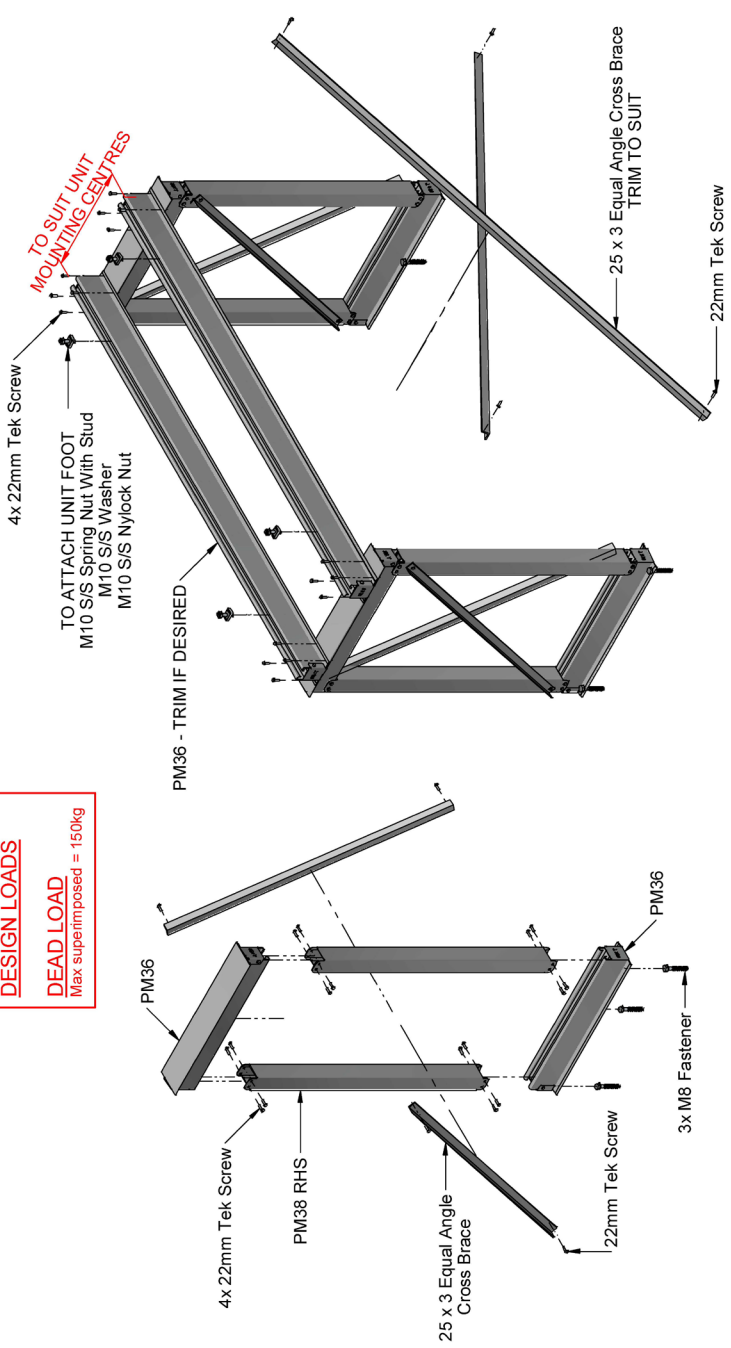

DRAWN BY:	KM
MODELED BY:	KM
PM:	BH
CHECKED BY:	BP/BD/LK
DATE DRAWN:	10/07/2019
LAST SAVED:	10/07/2019
MATERIAL:	SEE B.O.M.
FINISH:	MILL

Monkeytoe

EVERYTHING BETTER
0800 658 637 - www.monkeytoe.co.nz

CS025.10 - 1000mm Stacked Condenser Mount			
MONKEYTOE GROUP			
DWG No: 2004-CS025-10	2004		
	SHEET 1 OF 1	A3	REV:01
	SCALE: 1:15	DIMENSIONS IN MILLIMETERS	
DO NOT SCALE			